
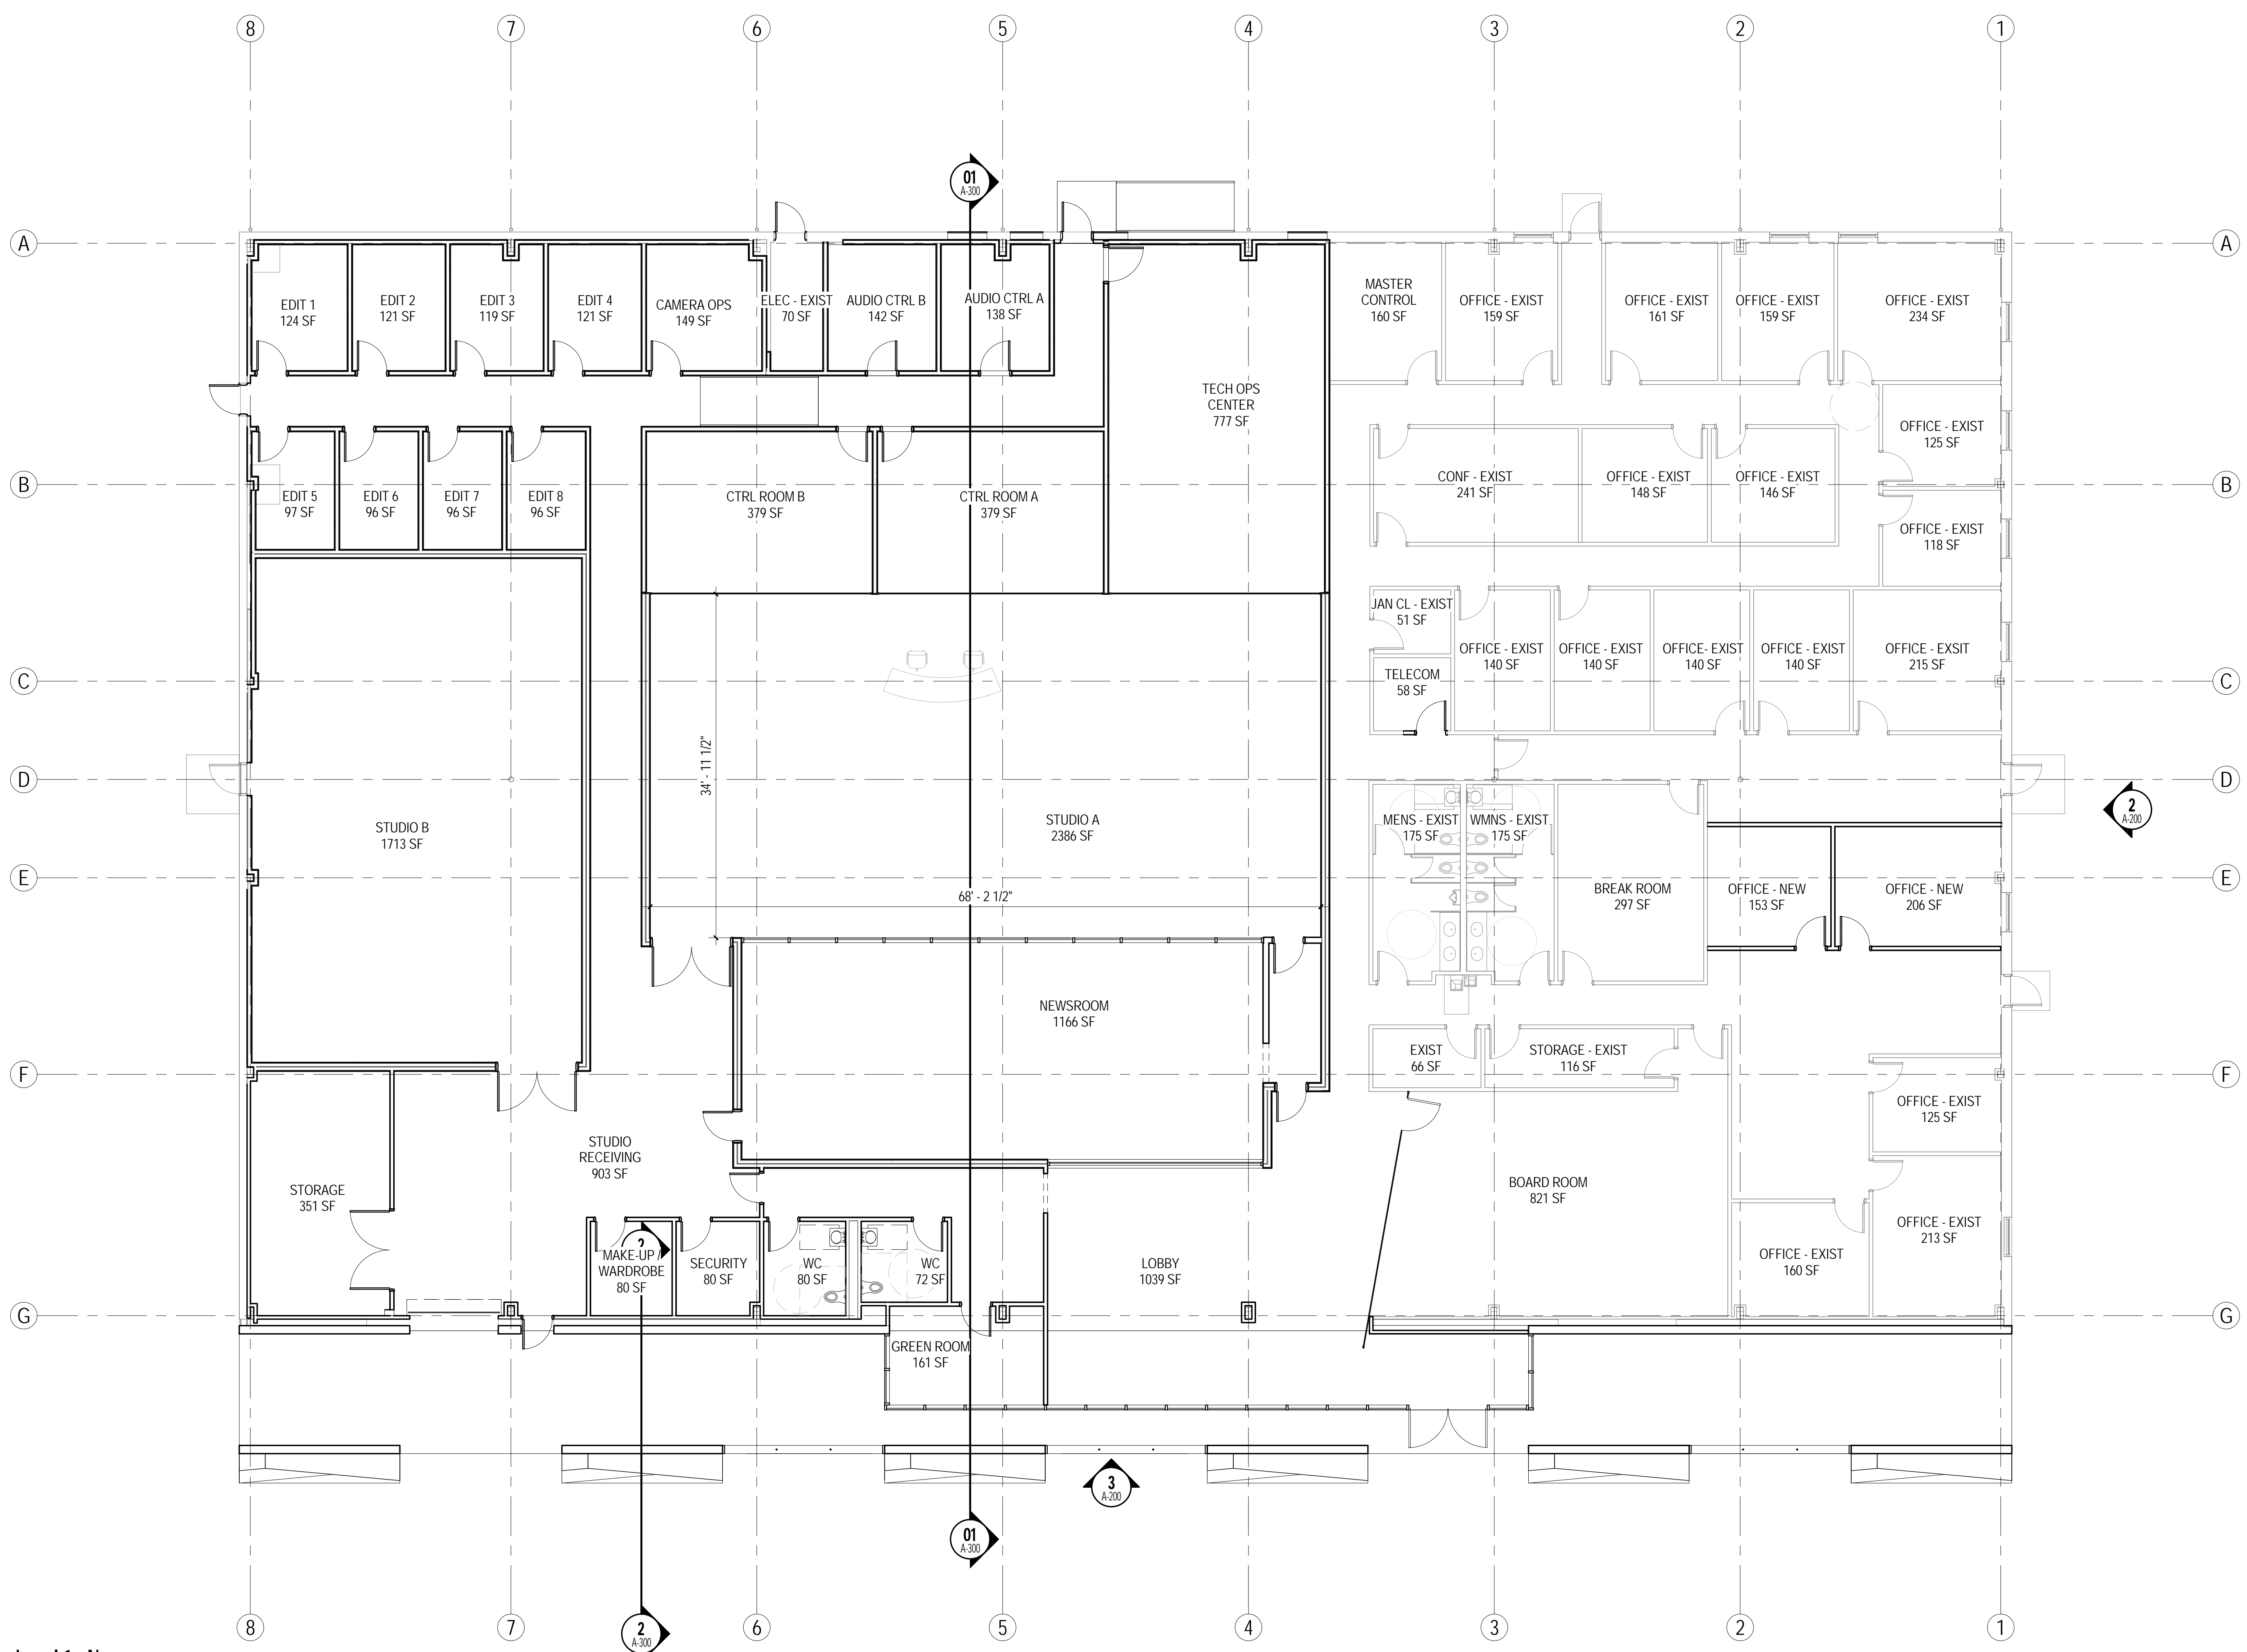


GENERAL NOTES:

1. WALL DIMENSIONS ARE TO FACE OF GYPSUM BOARD, OR CENTERLINE OF STRUCTURE, UNLESS NOTED OTHERWISE.
2. ALL OPENINGS IN CONCRETE AND CMU WALLS ARE DIMENSIONED TO THE ROUGH OPENING, UNLESS NOTED OTHERWISE.
3. ALL WINDOWS IN METAL STUD WALLS ARE DIMENSIONED TO THE CENTER OF WINDOW UNLESS NOTED OTHERWISE.
4. DOORS IN METAL STUD WALLS ARE LOCATED 4" FROM ADJACENT WALL FINISH SURFACE, TO THE EDGE OF FRAME UNLESS NOTED OTHERWISE.
5. ALL CONCRETE AND CMU WALLS, ADJACENT TO BELOW GRADE SLABS, ARE TO RECEIVE WATERPROOFING PER SPECIFICATION SECTION XXXXXX.
6. SEE WINDOW SCHEDULE AND DETAILS FOR WINDOW TYPES AND SIZES. WINDOW TYPES ARE DETERMINED BY THE WINDOW DESIGNATION TAG AS INDICATED ON PLANS AND ELEVATIONS.
7. ALL EXPOSED STRUCTURAL STEEL DETERMINED TO BE THE PRIMARY FRAME MEMBERS, WILL HAVE X HOUR RATING. SEE SPECIFICATION SECTION XXXXXX.
8. ALL CONCEALED STRUCTURAL STEEL DETERMINED TO BE THE PRIMARY FRAME MEMBERS, WILL HAVE X HOUR RATING. SEE SPECIFICATION SECTION XXXXXX.
9. ALL STRUCTURAL STEEL DETERMINED TO BE SUPPORTING ONLY THE ROOF WILL NOT HAVE X HOUR RATING. RATING WILL NOT BE REQUIRED FOR ROOF STEEL AT LOCATIONS WHERE THE BOTTOM OF STEEL FRAMING IS A MINIMUM OF 20'-0" ABOVE THE HIGHEST FLOOR LEVEL DIRECTLY BELOW. SEE SPECIFICATION SECTION XXXXXX.
10. SEE ROOM FINISH SCHEDULE AND MATERIALS LIST FOR ROOM FINISHES.
11. SEE DOOR SCHEDULE AND DOOR FINISH SCHEDULE FOR ALL DOOR INFORMATION.
12. SEE WALL TYPE SHEET FOR ALL INTERIOR WALL TYPES.



SHEET NOTES:

- 01 NOTE DESCRIPTION 1
- 02 NOTE DESCRIPTION 2 TEXT TEXT TEXT TEXT

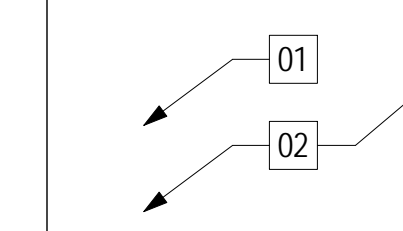

Level 1 - New
 1/8" = 1'-0"

01
 A-100

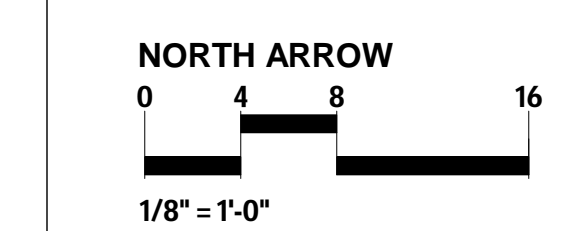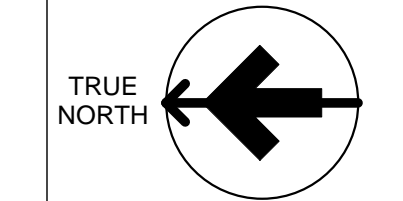

SEAL:

NO.	DESCRIPTION	DATE
-	ISSUE NUMBER 1	Date 1

CLIENT: BTNC

PROJECT NAME: BTNC TALLAHASSEE

PROJECT NUMBER: 2017-108

SHEET TITLE: FLOOR PLAN

ISSUE DATE: Sheet for References

DRAWING NUMBER: